



STRUCTURAL NOTES

1. DESIGN CRITERIA:
 - A. GROUND SNOW LOAD: 20 PSF
 - B. BASIC WIND SPEED: (3-SECOND GUST), 90 MPH, EXPOSURE B
 - C. SEISMIC: SITE CLASS: D
2. MASONRY
 - A. FACE BRICK SHALL BE ASTM C-216 OR C-652, GRADE NW, TYPE FBS, LAID UP IN STANDARD 3/8" MORTAR JOINTS OF TYPE N MORTAR.
3. STEEL
 - A. STEEL SHALL BE ASTM A-36, DESIGNED, DETAILED, AND ERECTED IN ACCORDANCE WITH THE LATEST AISC SPECIFICATIONS.
 - B. STEEL SHALL HAVE TWO GOOD COATS OF RED-CHROMATE PRIMER BEFORE INSTALLATION.
4. WOOD
 - A. ALL WOOD CONSTRUCTION SHALL BE DESIGNED, FURNISHED, AND ERECTED IN ACCORDANCE WITH THE LATEST AITC TIMBER CONSTRUCTION MANUAL AND N.D.S. REQUIREMENTS, LATEST EDITIONS.
 - B. ALL LUMBER TO BE NO. 2 SPF, UNLESS INDICATED OTHERWISE.
 - C. ALL WOOD IN CONTACT WITH MASONRY SHALL BE PRESSURE-TREATED FOR MOISTURE PROTECTION. ALL FASTENERS AND CONNECTORS IN CONTACT WITH PRESSURE-TREATED WOOD SHALL BE GALVANIZED.
5. THE STRUCTURE IS DESIGNED TO BE SELF-SUPPORTING AND STABLE AFTER IT IS FULLY ERECTED. IT IS THE CONTRACTOR'S RESPONSIBILITY TO DETERMINE ERECTION PROCEDURES AND SEQUENCE AND TO ENSURE THE SAFETY OF THE BUILDING AND ITS COMPONENTS DURING CONSTRUCTION.
6. RESPONSIBILITY TO CONFORM TO THE ENGINEER'S DRAWINGS AND SPECIFICATIONS IS THAT OF THE CONTRACTOR. THE ENGINEER CERTIFIES THAT HIS DESIGN IS IN ACCORDANCE WITH CURRENT APPLICABLE CODES AND SPECIFICATIONS, BUT TAKES NO RESPONSIBILITY FOR THE CONTRACTOR'S FAILURE TO CONFORM TO THEM.
7. SAFETY FACTORS HAVE BEEN INCLUDED IN THE DESIGN OF ALL MEMBERS.

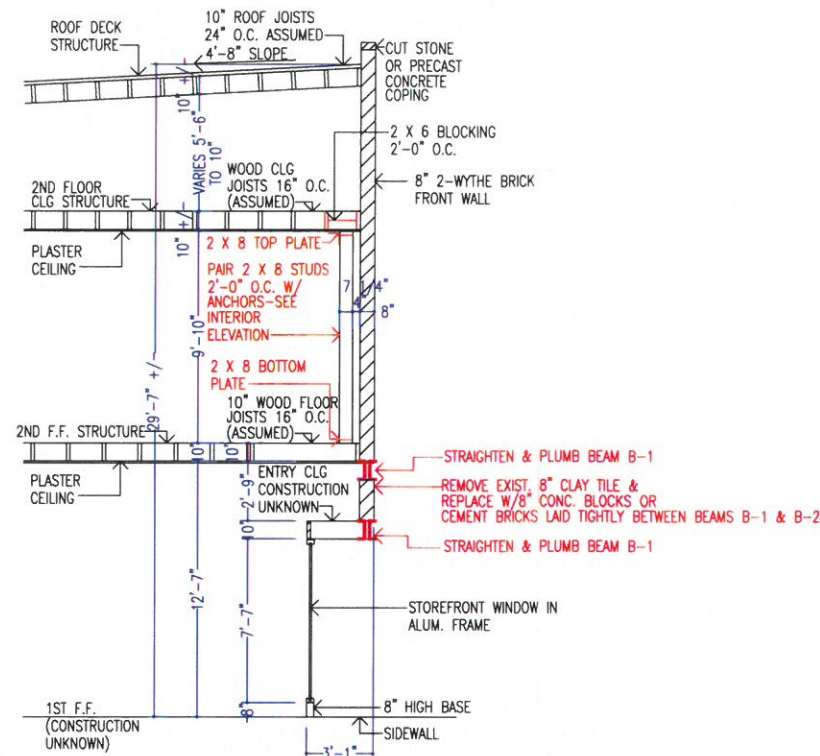


FRONT WALL SECTION (A)
SCALE: 1/4" = 1'-0"
(VERIFY ALL DIMENSIONS SHOWN)

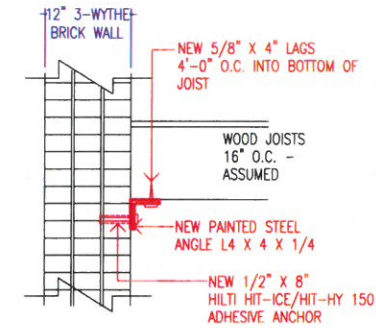

DETAIL (B)
SCALE: 1" = 1'-0"

| WINDOW SCHEDULE | |
|-----------------|---------------|
| MARK | APPROX. SIZE |
| A | 2'-6" X 6'-6" |
| B | 4'-6" X 6'-6" |
| C | 2'-2" X 6'-6" |

| BEAM SCHEDULE | | |
|---------------|------------------------------------|---------------------------|
| MARK | SIZE | REMARKS |
| B-1 | 2C 2 1/4" X 10" X 1/4"] | BOLTED TOGETHER |
| B-2 | 2C 2 1/4" X 10" X 1/4"] | BOLTED TOGETHER |
| B-3 | 2C 2 1/4" X 10" X 1/4"] (ASSUMED) | BOLTED TOGETHER (ASSUMED) |

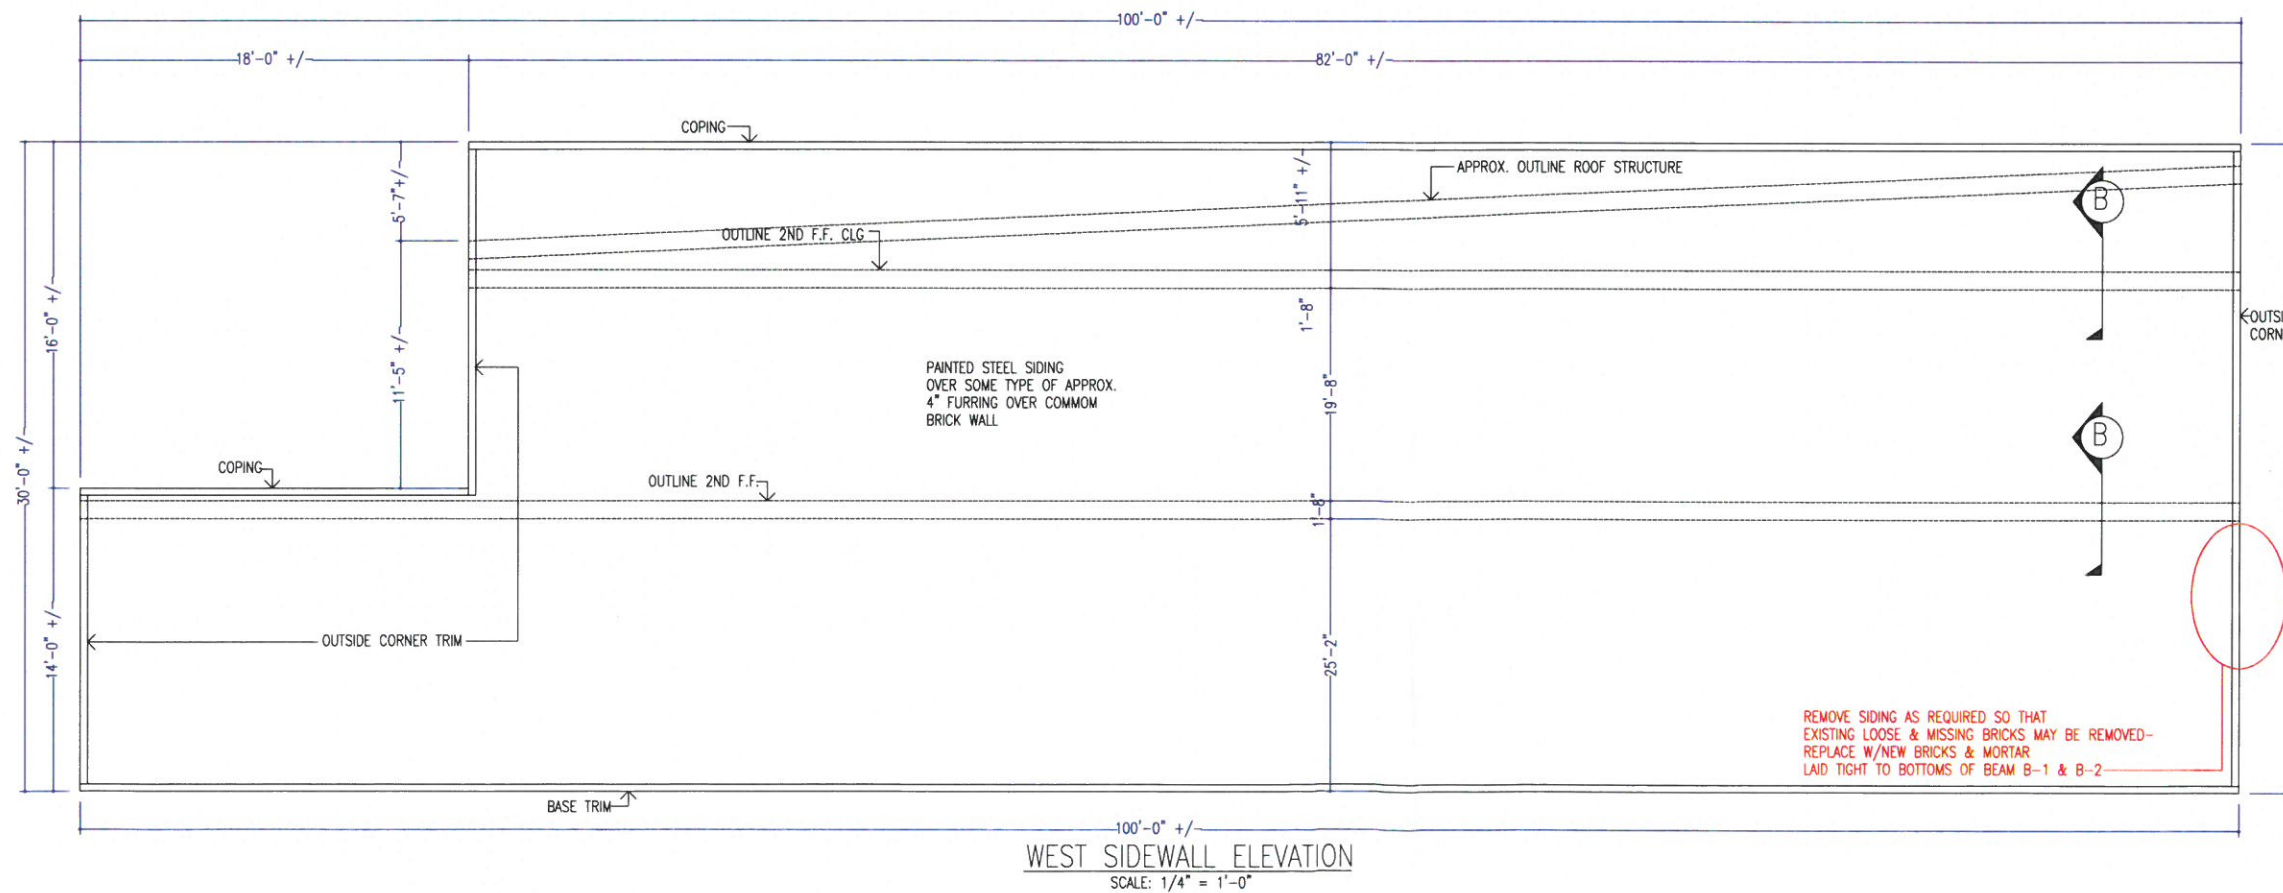

WEST SIDEWALL ELEVATION
SCALE: 1/4" = 1'-0"

ENGINEER: LARRY L. FAST, P.E.
4615 MITCHAW ROAD
SYLVANIA, OHIO 43560

PROJECT: JOHN & GRACEANN REESE
120 WEST WASHINGTON STREET
NAPOLEON, OHIO

REVISIONS:





DRAWN BY:
LOVANDA LAWSON

DATE:
7-21-2012

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46-12

SCANNED

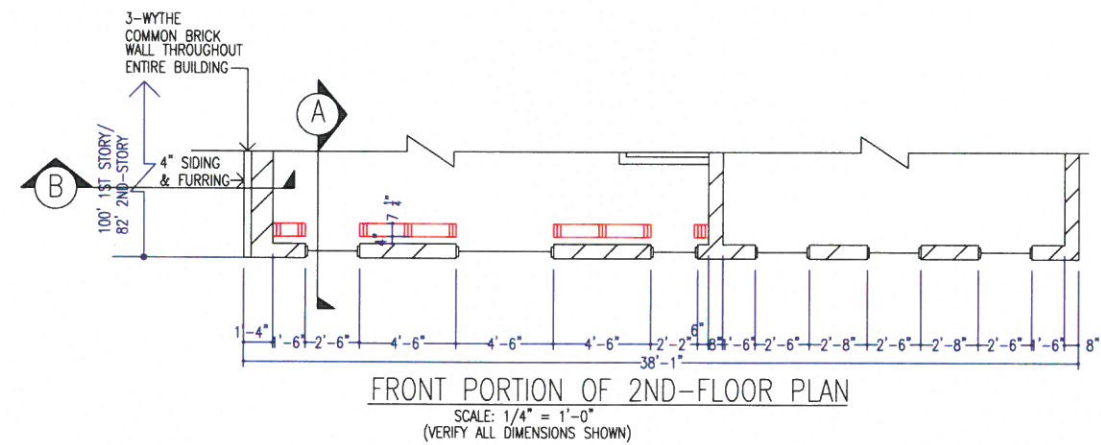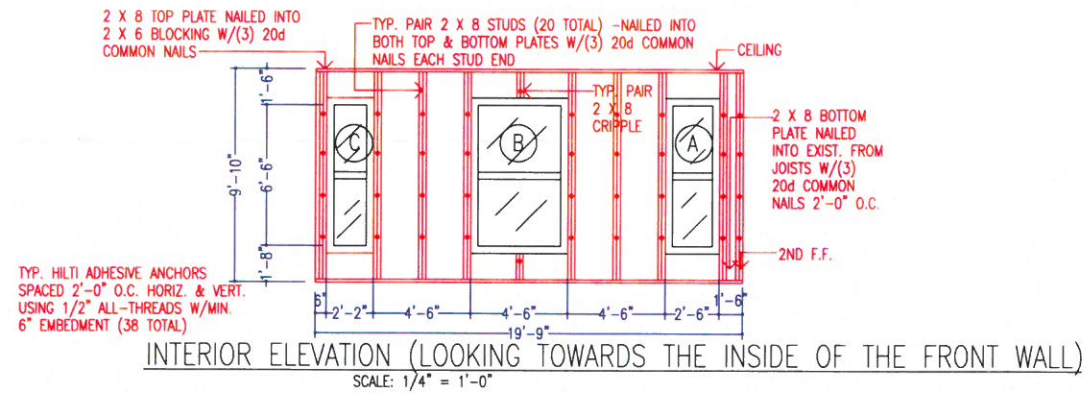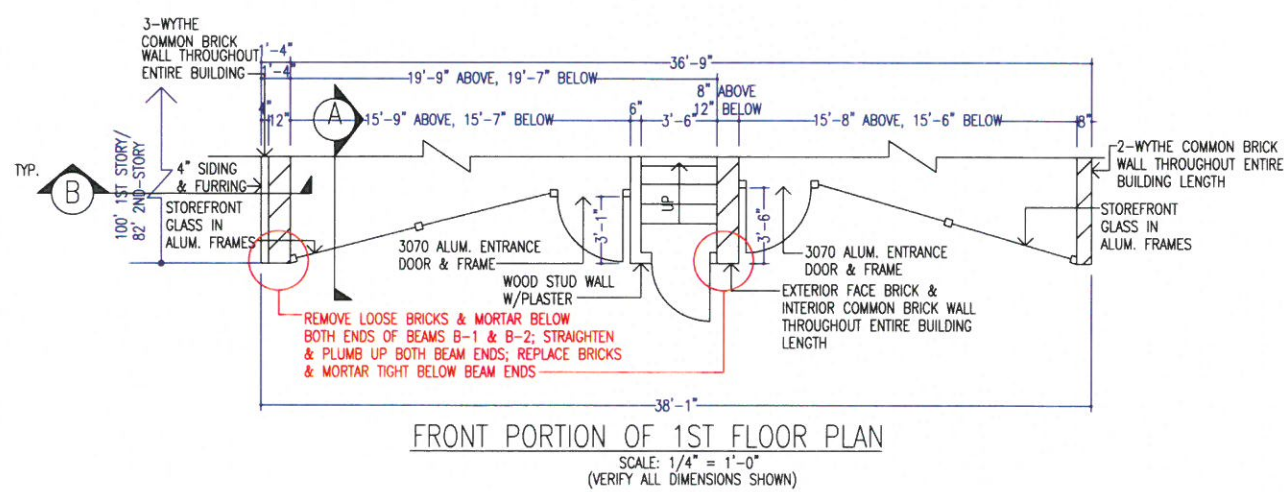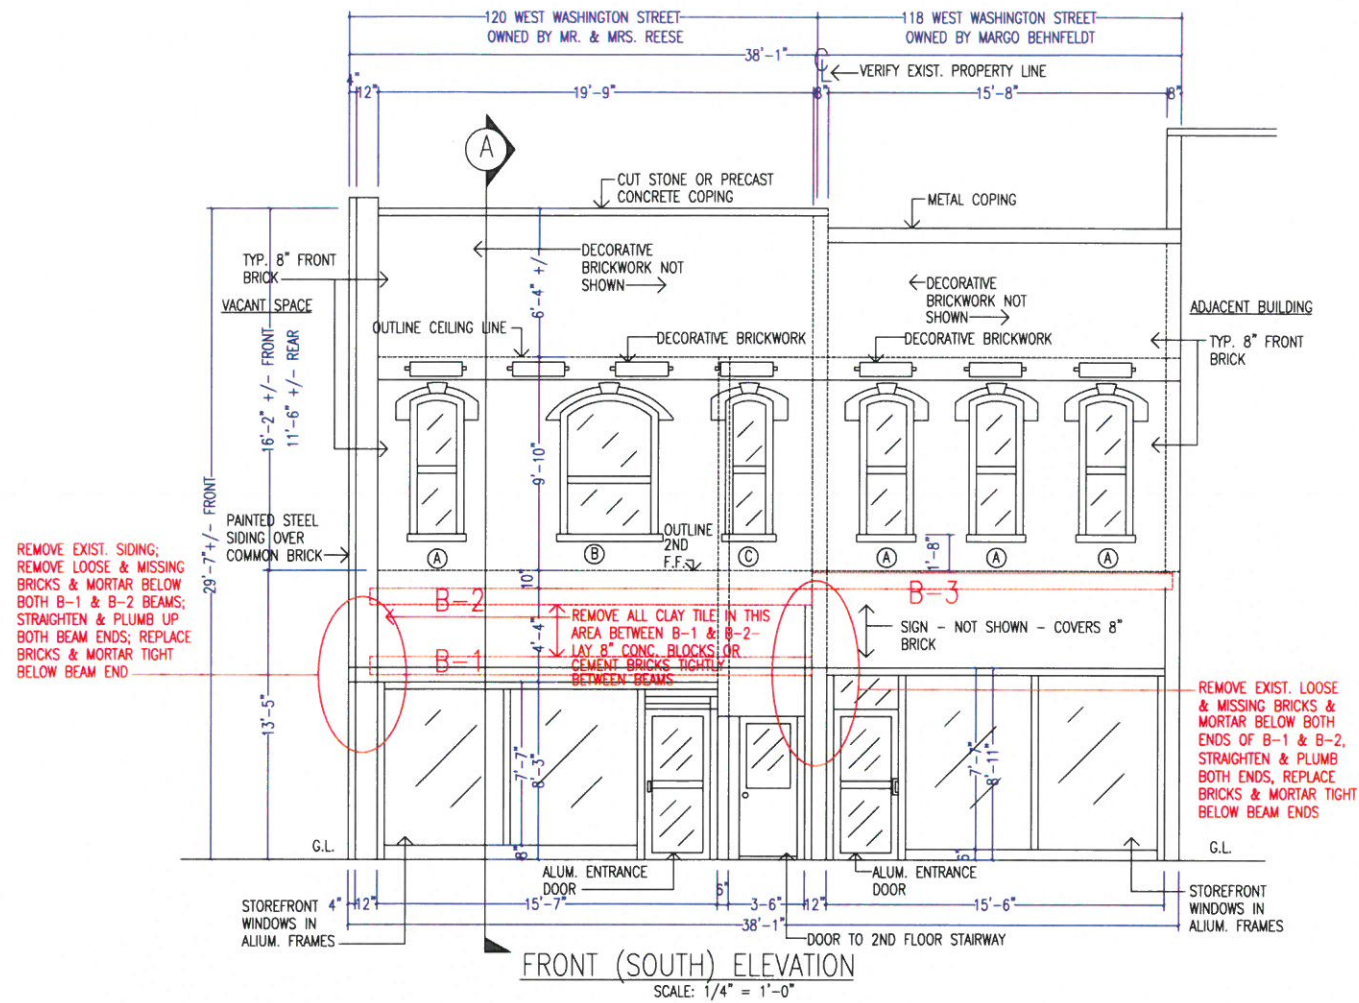

- GENERAL BUILDING NOTES
1. CODE: 2011 OHIO BUILDING CODE
 2. USE: B BUSINESS
 3. AREA: N.A.
 4. TYPE: IIIB
 5. OCCUPANT LOAD: N.A.
 6. DOORS & EXITS: N.A.

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S-1
1 OF 2

JOB # 46-12